


CRL STA. 176+70.09
 OKLAHOMA CITY BLVD. =
 CRL STA. 2+41.70
 S. SHARTEL AVE.
 N= 169,146.0113
 E= 2,109,742.1088

CRL STA. 181+89.64
 OKLAHOMA CITY BLVD. =
 CRL STA. 13+06.44
 S. LEE AVE.
 N= 168,894.9898
 E= 2,110,196.9235

CURVE #3
 P.I. Sta= 184+64.44
 Easting= 2110434.95
 Northing= 168757.48
 Delta L= 22°15'19.99"
 D= 2°51'53.24"
 T= 393.39'
 L= 776.87'
 R= 2000.00'
 E= 38.32'
 V= 25 mph

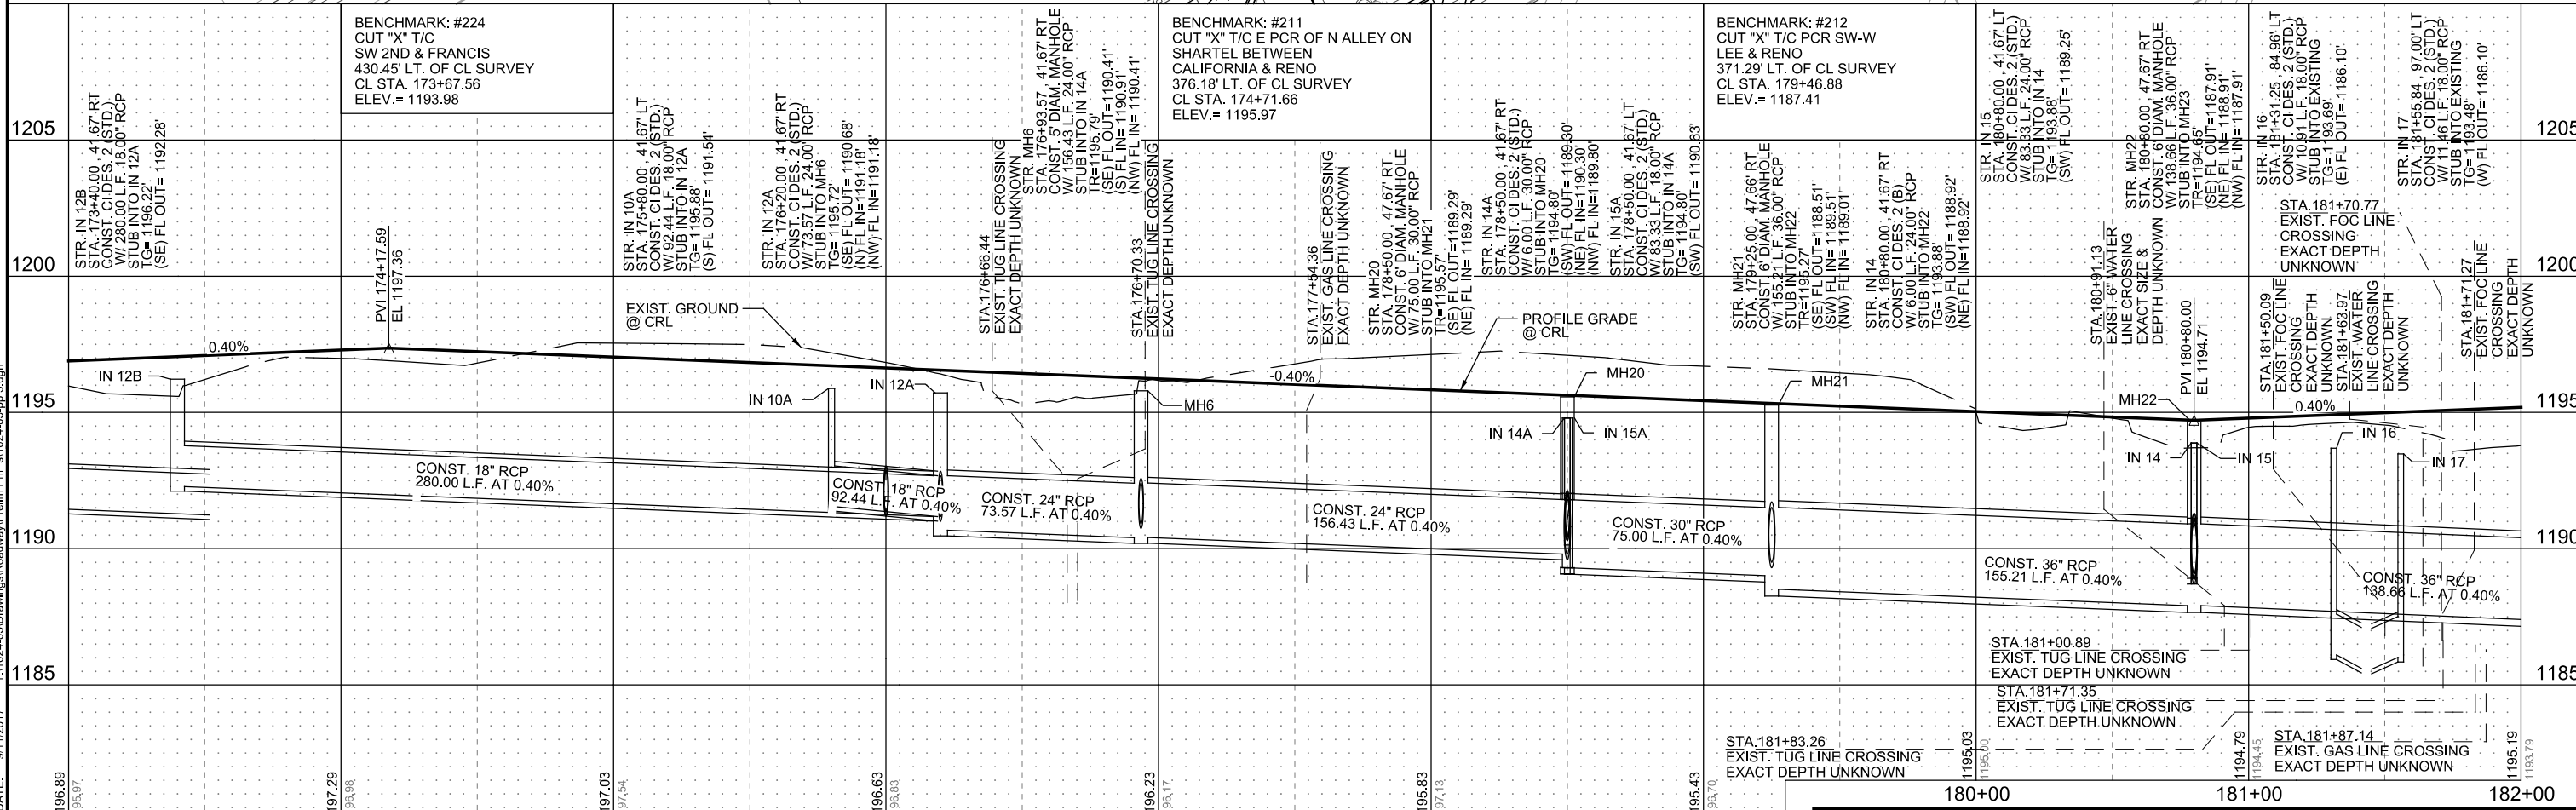

DATE: 9/11/2017 SCALE: PLAN: 1"=30'
 DRAWN BY: ISFM PROFILE: VERTICAL: 1"=5'
 HORIZONTAL: 1"=30'

STATE JOB NO. 17428(88) SHEET NO. 53

PLAN AND PROFILE - OKLAHOMA CITY BOULEVARD - OKLAHOMA COUNTY

PRINT DATE: 9/11/2017 T:\1024-05\Drawings\Roadway\Prelim\Plan\1024-05-pp_3.dgn